Cork County Council



Proposed Traffic Calming Works & Sustainable Travel Measures at Brookwood Estate on the R612 Crosshaven Road, Co. Cork


Section 38 Road Traffic Act, 1994

Drawing Schedule

Drawing No.	Drawing Title	Rev.	Scale	Size
PTSDT-ACM-GEO_GA_0016_198-19-DR-CR-0004_P01	Site Plan	P01	1:2000	A3
PTSDT-ACM-GEO_GA_0016_198-19-DR-CR-0003_P01	Consultation Drawing	P01	1:300	A3

SUSTAINABLE TRAVEL UNIT

Floor 2 County Hall Carrigrohane Road, Cork, T12 R2NC

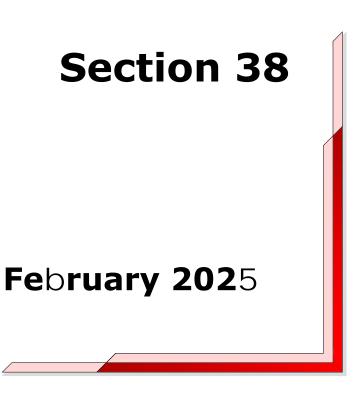



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contained herein does not purport to be comprehensive or final as the apparatus is subject to being altered and/or superceded. Recipients should not rely on this information. Any liabilities

are hereby expressly disclaimed.


information or any part of it). Any liabilities are hereby expressly disclaimed.



R612


PPROPOSED BROOKWOOD WESTBOUND STOP LOCATION

Rev	Date	Drn	Chk'd	App'd	Description	Client	Engineering Designer			
P01	07/01/2025	HS	LN	ADR	ISSUE FOR PRELIMINARY DESIGN	NT				
						Údarás Ná	isiúnta lompair		AECO/	
							insport Authority			
						Date 07/01/2025	Scale 1:1000 @ A1 1:2000 @ A3	Drawn HS	Checked LN	Approved ADR
						Phase	-	Stop Number	I	
						1	16	197, 198		

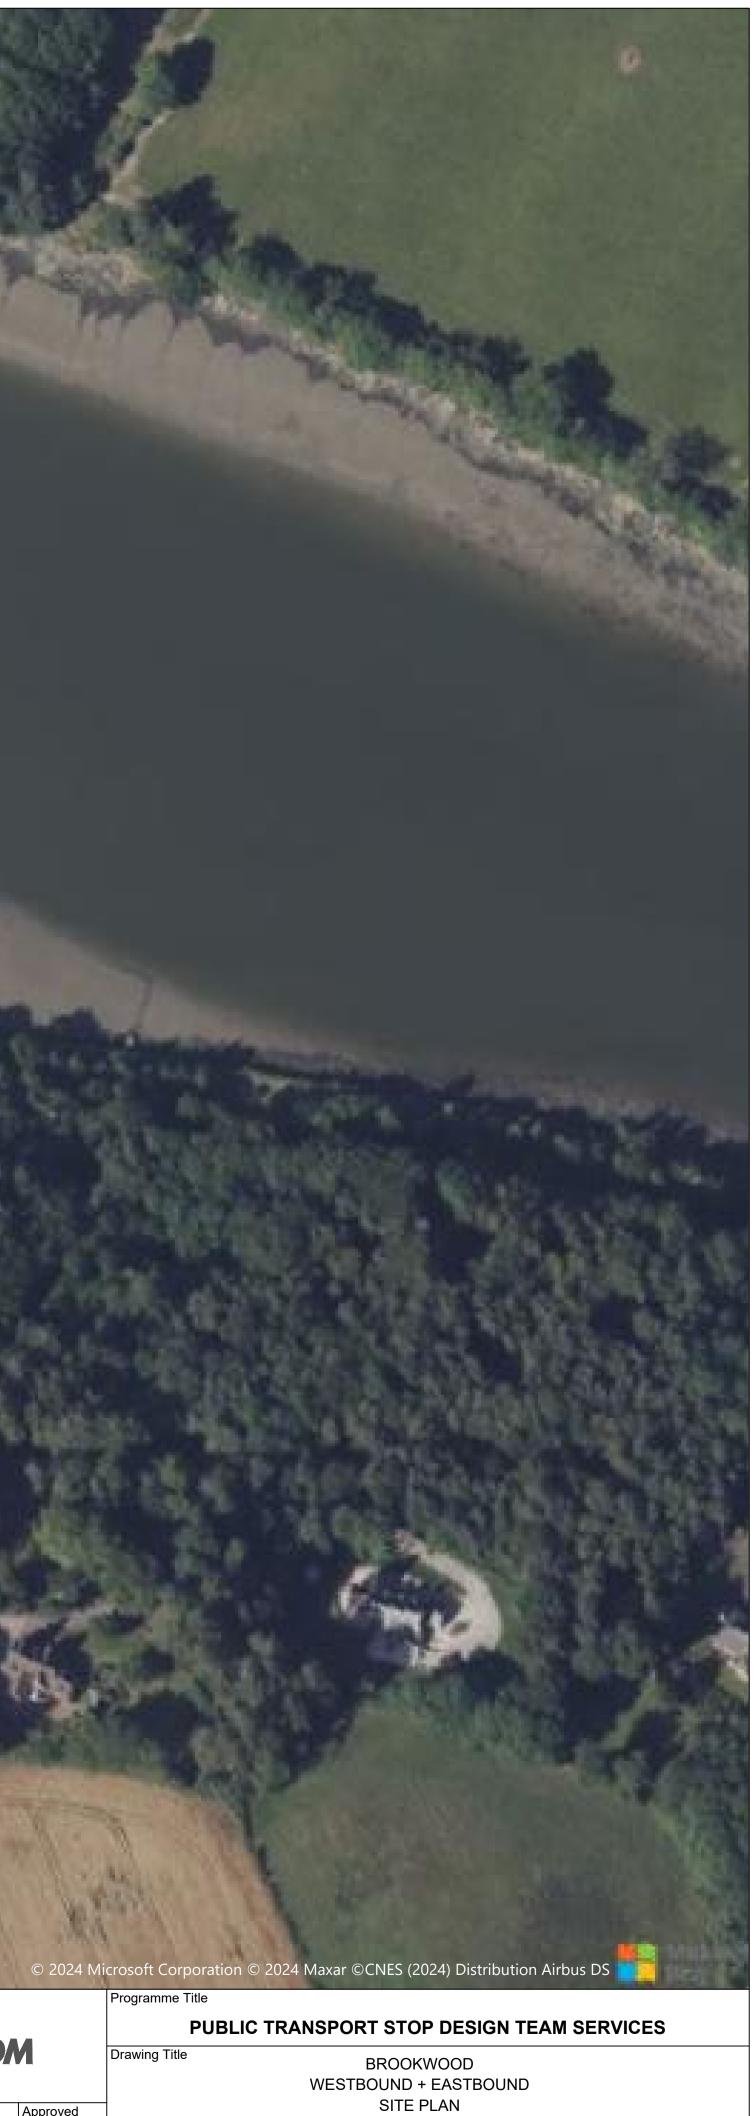

Rev

P01

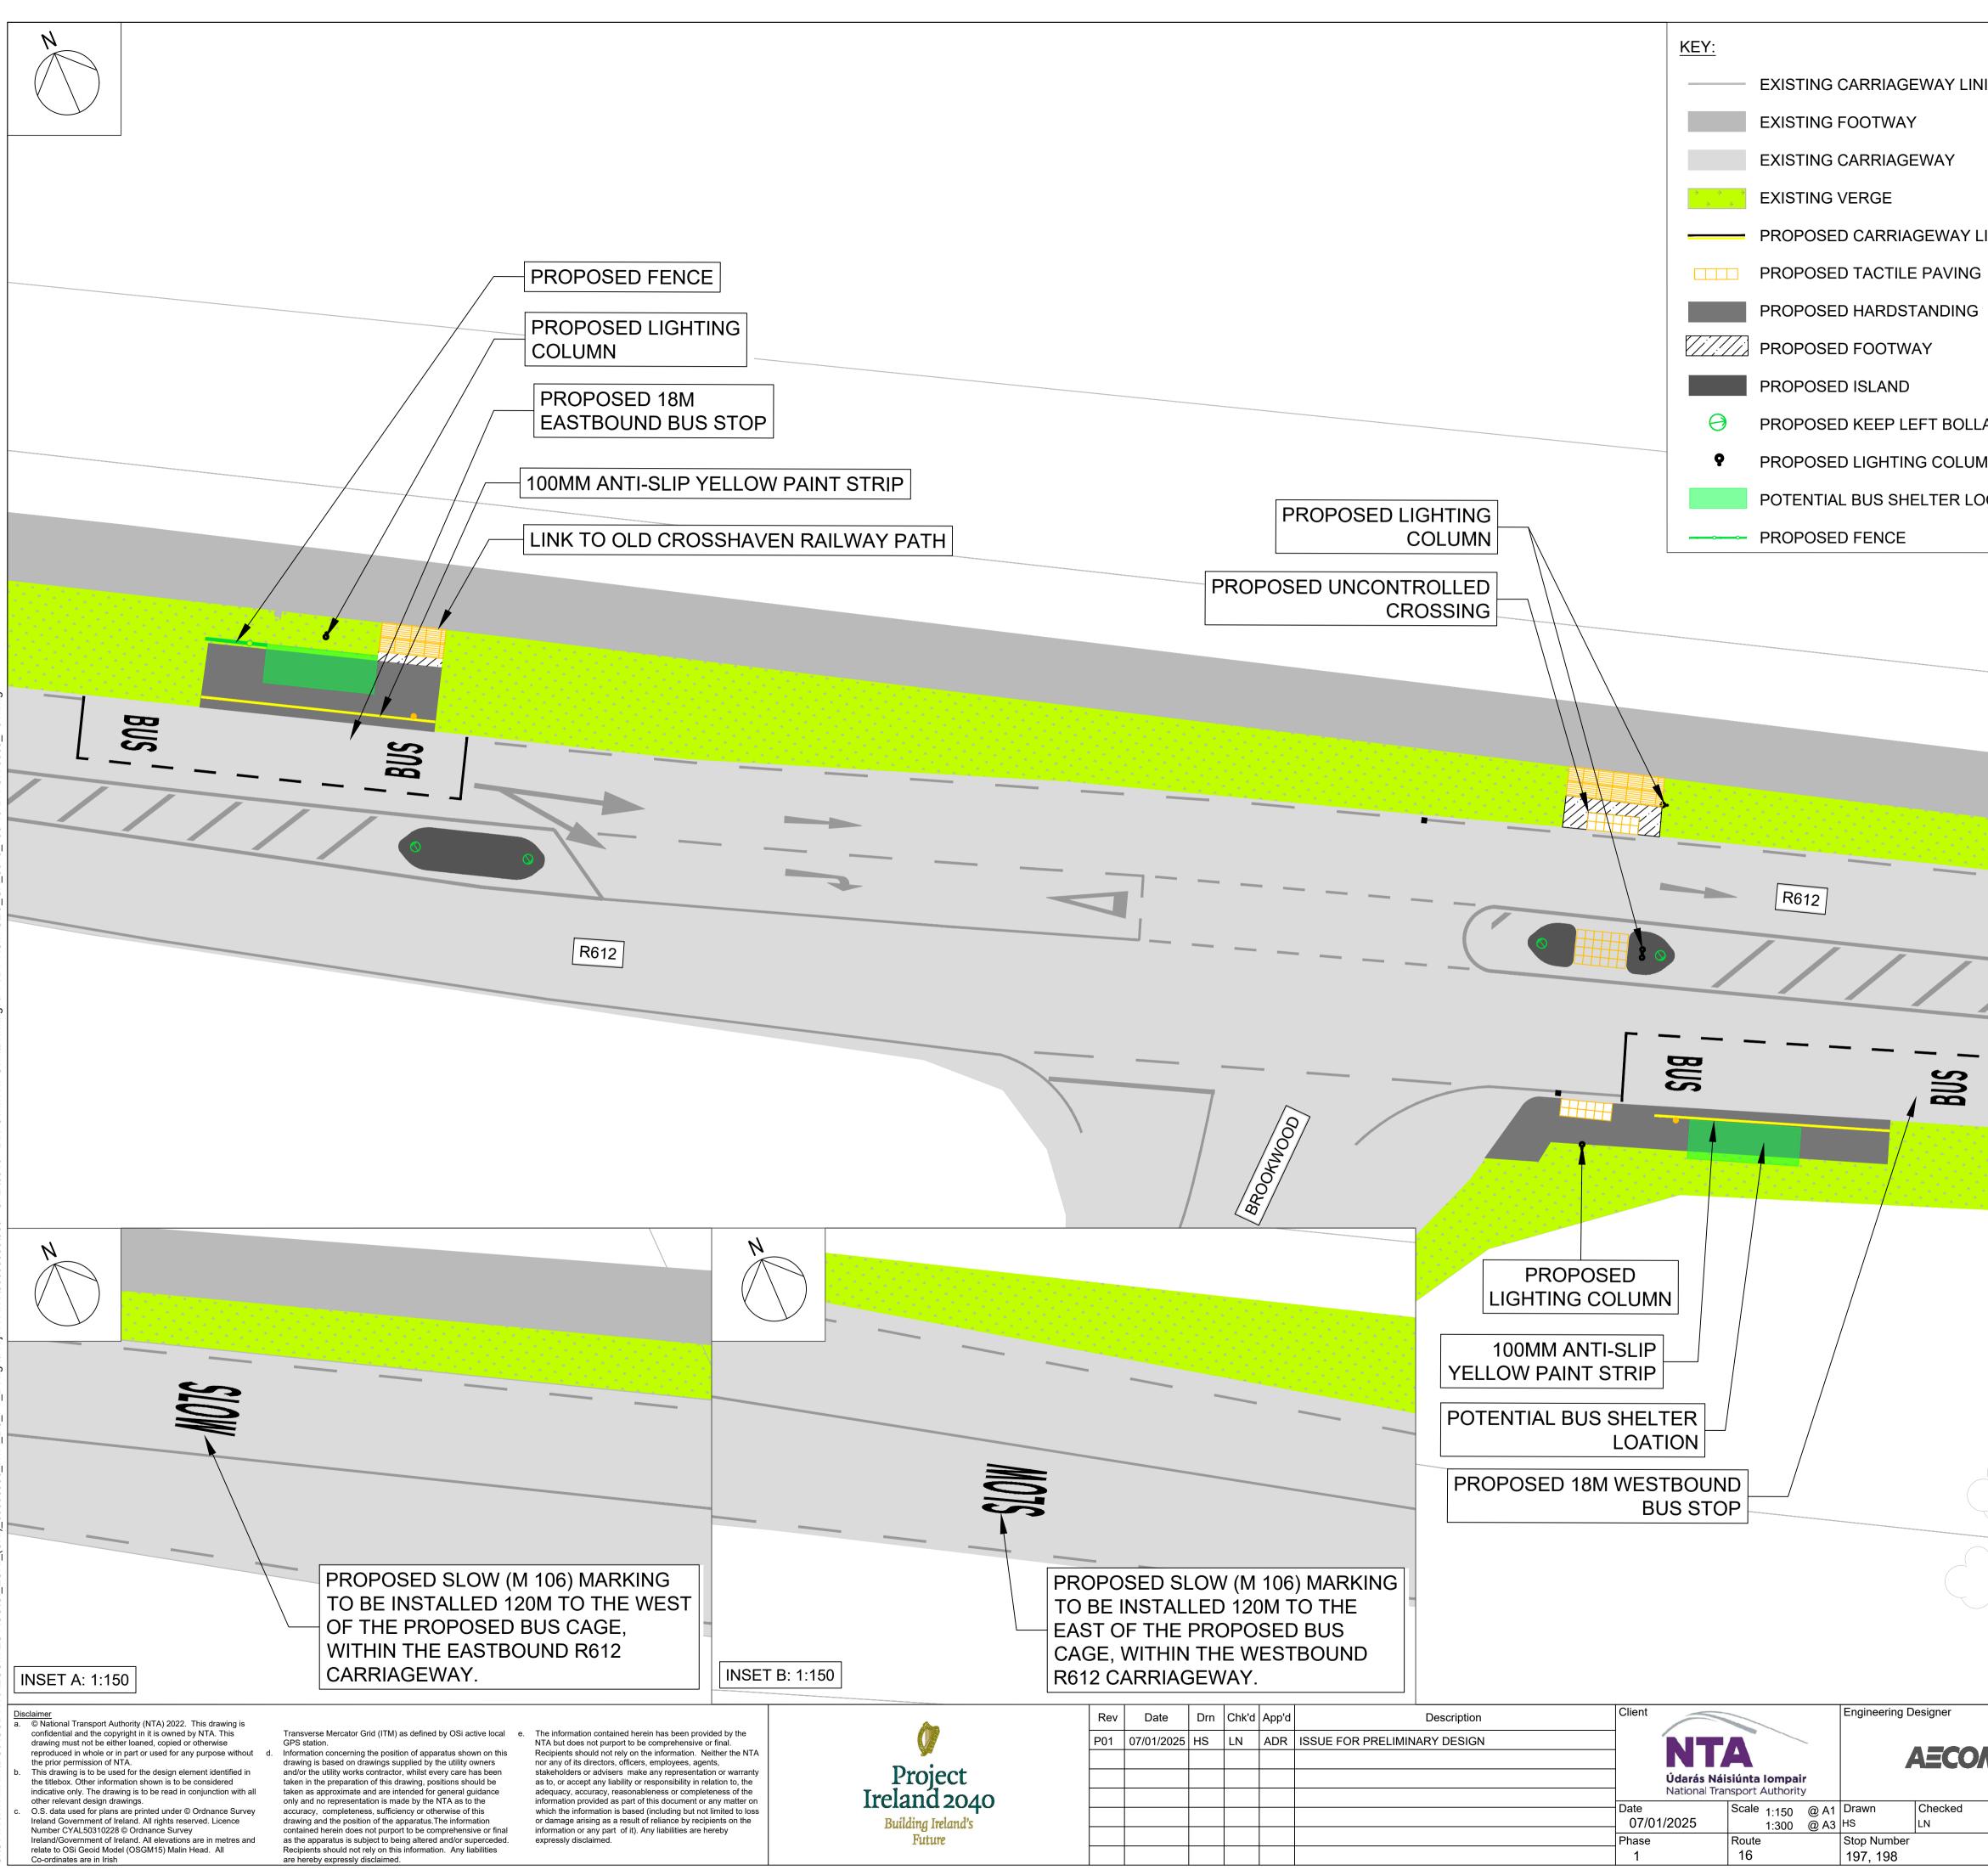

DO NOT SCALE USE FIGURED DIMENSIONS ONLY

NING LINING	 Proposal Summary The bus network in Cork has been comprehensively redesigned as part of the BusConnects Cork programme. The redesign work was carried out in partnership with the City and the County Councils to ensure full integration with local, regional and national policy. There was extensive engagement with the public and with stakeholders. The new bus network will provide over 50% more service than existing, an unprecedented investment in Cork's
G	public transport. More areas are being served; more people are within walking distance of a high frequency and there will be more 24-hour operation.
LARD MN OCATION	It is planned to deliver these benefits during 2025 and 2026. Certain infrastructure is required to allow the new network to be operated. Buses need a means of turning around at the new endpoints of the new/extended routes. Excellent reliability depends on layover space at the terminal to allow time in schedules for any late-running bus to return on time on its next trip. A detailed operational review of the new bus network has now identified the shorter-term stop and terminus alterations needed to support the introduction of the
	 new bus system. Proposal The proposed works are summarised as follows: 1) Proposed hardstandings to be installed in the existing grass verge. 2) Accessible kerbing to be provided along the length of the eastbound and westbound bus boarding area.
	 3) 2.4m wide uncontrolled crossing with tactile paving to connect the two proposed stops across the R612. 4) Existing arrow marking to be relocated east of the proposed westbound bus cage. 5) Lighting columns to be installed. 6) Footway to be installed to connect the existing footway to the proposed eastboud bus stop and to the uncontrolled crossing. 7) Central island to be installed next to the proposed eastbound stop and a central island to be installed at the uncontrolled crossing. 8) Renewal/replacement of other road drainage, road signage and road markings as might be necessary.
	9) All other associated ancillary site works. The scheme has been designed in accordance with the Design Manual for Urban Roads and Streets and, where relevant, the TII Design Manual for Roads & Bridges. All layouts and details are indicative for consultation purposes and may be subject to change.
	Bus Stop Plate Number:
Approved ADR	PUBLIC TRANSPORT STOP DESIGN TEAM SERVICES Drawing Title BROOKWOOD WESTBOUND + EASTBOUND CONSULTATION DRAWING Drawing File Name Sheet Number Status Rev PTSDT-ACM-GEO_GA_0016_198-19-DR-CR-0003 1 of 1 S0 P01
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