

EACH HOUSE TO HAVE NEW INDIVIDUAL CONNECTIONS TO NEW PUBLIC FOUL SEWER.

ALL FOUL DRAINAGE WORKS OUTSIDE SITE BOUNDARY IN PUBLIC AREA TO BE CARRIED OUT BY UISCE EIREANN.

ALLOW FOR CROSSING UNDER/OVER EXISTING & PROPOSED SERVICES, SEWER & DRAINS.

DRAINAGE NOTES:

- All Drainage works should comply with:
 (A) Requirements of BS 8005: Part 1 and BS 830. (B) "Recommendations for Site Development Works for Housing Areas" by Department of the Environment and Local Government 1998. (C) Current Irish Water Standard Details and
- Code of Practice for Wastewater Infrastructure. (D) Current Building Regulations.
- Drainage Covers (a) Manhole covers to roads to be Cavanagh MAESTRO Class D400 to EN 124 or equivalent approved. (b) Covers to Armstrong Junctions & Linear Surface Drains in driveways to be Class D400 to EN 124 or equivalent approved.
- Land Drains Land drains to be 150mm diameter (Agrement Approved) and surrounded in pea gravel and terram and connected to the nearest main storm drainage system.
- 4. Pipes passing through Walls (a) Where pipes pass through walls, lintels to be used to give a minimum clearance of 50mm to pipe.




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Original Drawing Size A1

Notes

- DO NOT SCALE DRAWING. USE FIGURED DIMENSIONS ONLY. THIS DRAWING IS TO BE READ IN CONJUNCTION WITH ALL OTHER RELEVANT ARCHITECTURAL, MECHANICAL/ELECTRICAL AND
- ENGINEERING DRAWINGS. 3. FOR ALL SETTING OUT, REFER TO ARCHITECTS DETAILS.
- 4. ALL WORKS CARRIED OUT MUST COMPLY WITH THE RELEVANT PARTS OF THE CURRENT BUILDING REGULATIONS AND TECHNICAL GUIDANCE DOCUMENTS, ENSURING THE WORKS ARE CARRIED OUT USING 'PROPER MATERIALS WHICH ARE FIT FOR USE FOR WHICH THEY ARE INTENDED AND FOR THE CONDITIONS IN WHICH THEY ARE USED'.
- 5. ALL MATERIALS USED SHALL BE 'CE' MARKED IN ACCORDANCE WITH THE EU CONSTRUCTION PRODUCT REGULATIONS (CPR) (No.305/2011). REFER TO ANNEX IV OF THE REGULATIONS FOR THE LIST OF APPLICABLE PRODUCTS.
- 6. THIS DRAWING TO BE READ IN CONJUNCTION WITH RKA GENERAL CIVIL & STRUCTURAL SPECIFICATION.
- ENGINEER TO BE INFORMED OF ANY DISCREPANCIES IMMEDIATELY. POSITIONS OF EXISTING SEWERS & MANHOLES SHOWN ON THIS DRAWING ARE INDICATIVE ONLY. ACTUAL POSITIONS OF SEWERS MUST BE ESTABLISHED ON SITE BY THE CONTRACTOR BY HAND
- DUG TRIAL HOLES. RKA CONSULTING ENGINEERS WILL NOT ACCEPT ANY RESPONSIBILITY FOR THE POSITIONAL ACCURACY OF THE SEWERS/MANHOLES SHOWN ON THIS DRAWING NOR ANY OMMISSION FROM SAME OF SEWERS/MANHOLES WHICH ARE NOT SHOWN ON THE PLAN.
- 10. CONTRACTOR TO ALLOW FOR LOCATING ALL EXISTING SEWERS/MANHOLES AS REQUIRED TO ACCOMMODATE DIVERSION AND/OR REPLACEMENT OF EXISTING SEWERS AS SHOWN ON THIS
- 11. CONTRACTOR TO ENSURE THAT SEWERS ARE MAINTAINED TO ALL EXISTING USERS AT ALL TIMES DURING THE CONTRACT.
- 12. CONTRACTOR TO ALLOW FOR HAND DIGGING TO LOCATE EXISTING SERVICES AS REQUIRED.
- CONTRACTOR TO KEEP FULL RECORDS OF POSITIONS OF ALL PIPEWORK AND CONNECTIONS AND ON COMPLETION, FULL AS-BUILT
- DRAWINGS TO BE PRODUCED BY THE CONTRACTOR. 14. WORKS TO BE CARRIED OUT IN ACCORDANCE WITH
- UTILITY PROVIDERS LATEST SPECIFICATIONS.
- 15. WORKS TO BE CARRIED OUT IN ACCORDANCE WITH CORK COUNTY COUNCIL DESIGN GUIDE FOR PROVISION OF SERVICES IN HOUSING ESTATES 2005 & RECOMMENDATIONS FOR SITE DEVELOPMENT WORKS FOR HOUSING AREAS 1998, PUBLISHED
- BY THE DEPARTMENT OF ENVIRONMENT & LOCAL GOVERNMENT. 16. SETTING OUT TO BE THE RESPONSIBILTY OF THE CONTRACTOR.



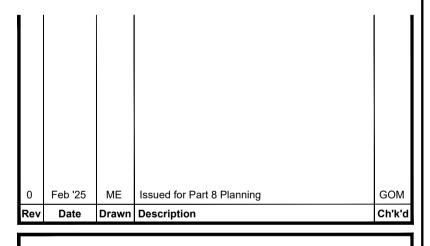

CORK COUNTY COUNCIL


Proposed Residential Development at Church Road, Durrus, Co.Cork

Proposed Foul Drainage Layout

Designed: GOM | Drawn: ME | Date: February 2025 Eng Chk: GOM Dwg. Chk: GOM Scale: 1:200 @ A1

0600825 Project. No: Drawing No:

500

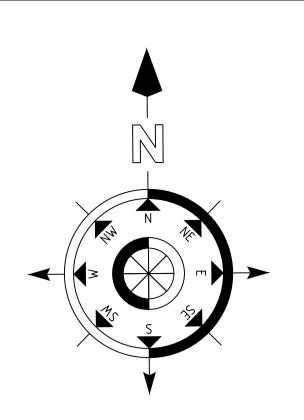

LEGEND:

SITE BOUNDARY OUTLINED IN RED

EXISTING 300 DIA. STORM LINE

PROPOSED 300mm DIA. LAND DRAIN

PVC STORM LINE @ 1:200 FALL

PVC STORM LINE @ 1:107 FALL

PROPOSED 225mm DIA.

LINEAR DRAIN WITH 150mm BRANCH CONNECTION

S02 (•)

STORM MANHOLE No.02

PROPOSED 225mm DIA.

GY IIII

PROPOSED ROAD GULLY WITH 150mm PVC BRANCH CONNECTION

PROPOSED BYPASS SEPARATOR (SEE NOTE A)

NOTE A - BYPASS SEPARATOR:

THE BYPASS SEPARATOR CHOSEN IS TO BE IN ACCORDANCE WITH EN 858-1 AND ITS DESIGN IS TO INCLUDE THE NECESSARY VOLUME REQUIREMENTS FOR:

-OIL SEPARATION CAPACITY -SILT STORAGE CAPACITY -OIL STORAGE VOLUME -COALESCER

THE BYPASS SEPARATOR CHOSEN, WHICH IS TO BE AGREED WITH THE CLIENTS REPRESENTATIVE IS TO BE OF ROTOMOULDED CHAMBER CONSTRUCTION AND IS TO CATER FOR AN IMPERMEABLE AREA UP TO 2,100 SqM.

EACH HOUSE TO HAVE NEW INDIVIDUAL CONNECTIONS TO NEW STORM DRAIN.

NEW STORM DRAIN TO BE ENCASED IN 150mm CONCRETE SURROUND UNTIL COVER IS 1.2m.

ALLOW FOR CROSSING UNDER/OVER EXISTING & PROPOSED SERVICES, SEWER & DRAINS.

DRAINAGE NOTES:


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- Land Drains Land drains to be 150mm diameter (Agrement Approved) and surrounded in pea gravel and terram and connected to the nearest main storm drainage system.

NEW 225mm DIA. STORM DRAIN TO BE SURROUNDED IN GRANULAR MATERIAL

AND COVERED WITH A 150mm THICK REINFORCED CONCRETE SLAB ALL IN ACCORDANCE

WITH UISCE EIREANN WASTEWATER INFRASTRUCTURE STANDARD DETAIL STD-WW-08

4. Pipes passing through Walls (a) Where pipes pass through walls, lintels to be used to give a minimum clearance of 50mm to pipe.

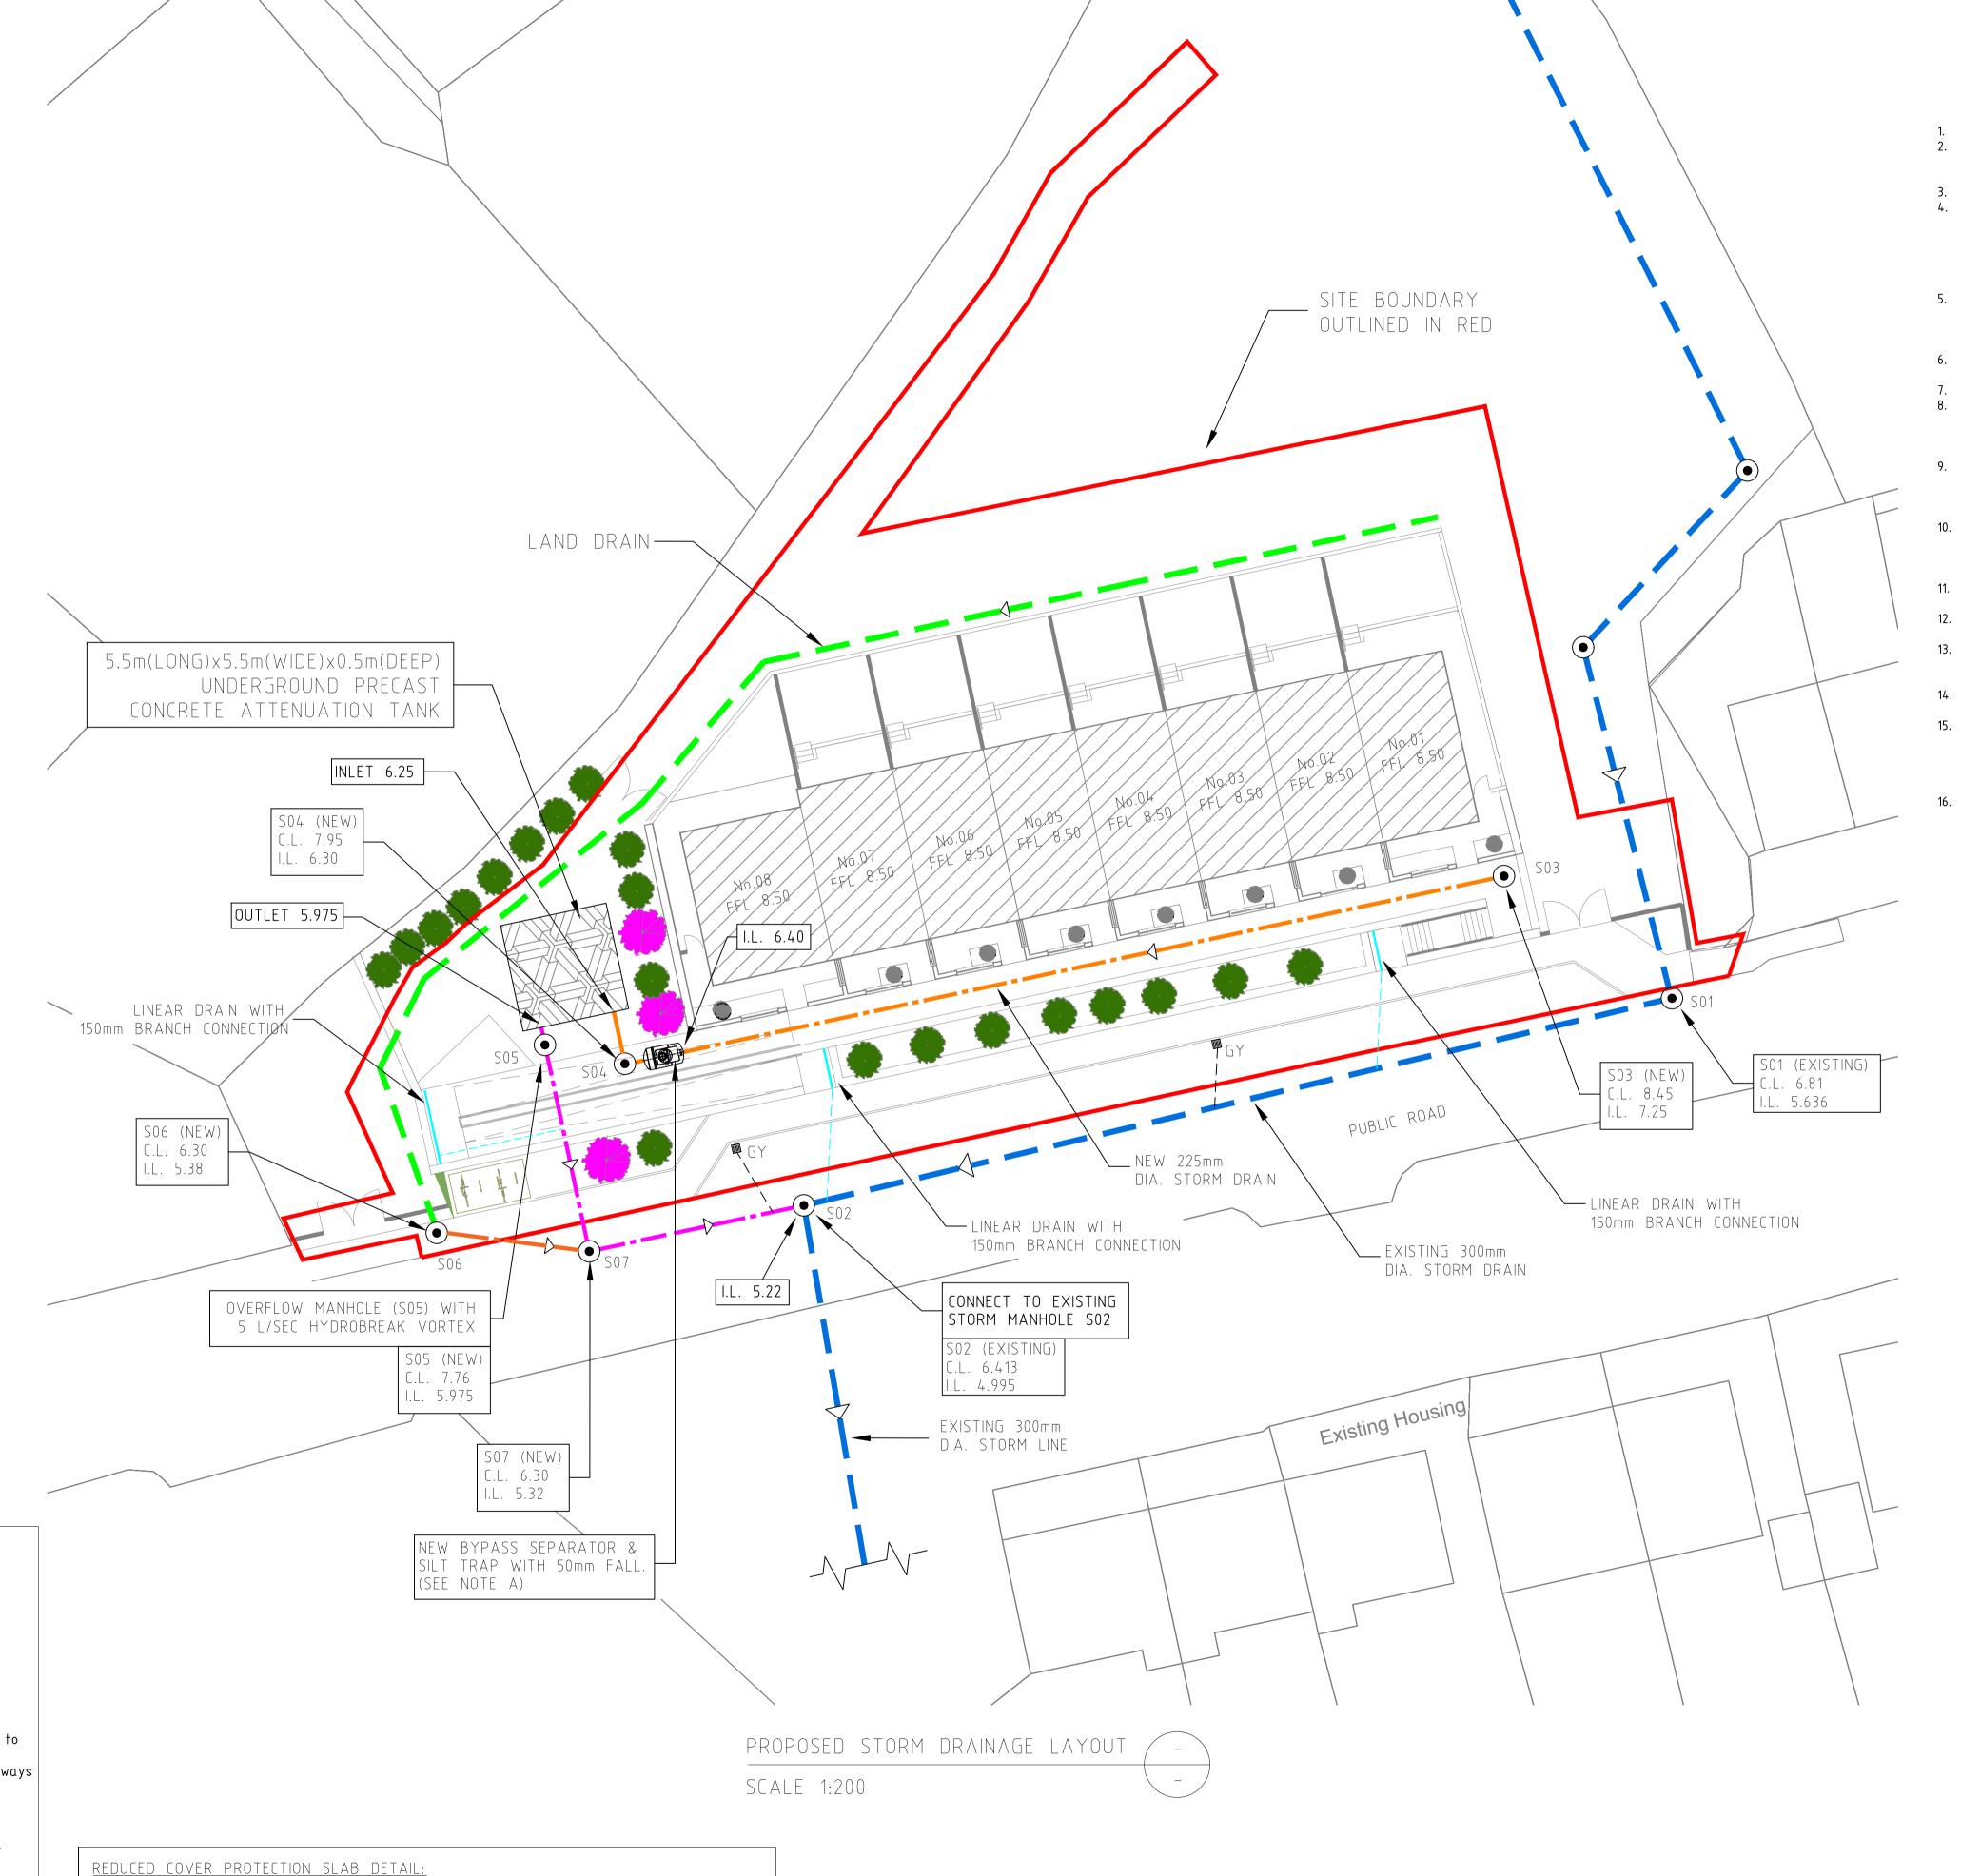

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Feb '25 ME Issued for Part 8 Planning Date Drawn Description



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CIVIL | STRUCTURAL | PROJECT MANAGEMENT

CORK COUNTY COUNCIL

Proposed Residential Development at Church Road, Durrus, Co.Cork

Proposed Storm Drainage Layout

Designed: GOM Drawn: ME Date: February 2025 Eng Chk: GOM Dwg. Chk: GOM Scale: 1:200 @ A1

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